

### TOWN AND VILLAGE OF ELLICOTTVILLE BUILDING & PLANNNG DEPARTMENT



#### PO BOX 600, ELLICOTTVILLE, NY 14731

Planner: Greg Keyser, (716) 801-3016, E-MAIL: greg.keyser@evlengineering.com

Code Officer: Kelly Fredrickson, (716) 699-4773, E-MAIL: kelly.fredrickson@evlengineering.com

### **COMBINED APPLICATION**

Jurisdiction: <u>TOWN</u>	VILLAGE App. # ZP24-0003
PRE-APPLICATION CONFERENCE	SPECIAL USE PERMIT
INTENT TO SUBDIVIDE	MASTER PLANNED DEVELOPMENT
HISTORIC DISTRICT REVIEW	✓ ARCHITECTURAL DESIGN REVIEW
SITE PLAN REVIEW	AMENDMENT TO SITE PLAN
ZONING ORDINANCE AMENDMENT	ZONING MAP AMENDMENT
APPLICANT INFORMATION:	
Applicant's name: Town of Ellicottville	Date: 1/29/2024
Mailing address: 1 W Washington Street, P	
Cell Phone Number: n/a	E-Mail: n/a
Applicant must be (check all that apply):	
Applicant's Engineer or representative: Ben Slot	man, P.E.
Address: 1 W Washington Street, PO Box	600
Address: 1 W Washington Street, PO Box Phone #: (716) 699-9005	600 <sub>E-Mail:</sub> ben.slotman@evlengineering.com
Phone #: (716) 699-9005	E-Mail: ben.slotman@evlengineering.com
	E-Mail: ben.slotman@evlengineering.com
Phone #: (716) 699-9005 PROPERTY OWNER INFORMATION (if diffe	E-Mail: ben.slotman@evlengineering.com
Phone #: (716) 699-9005 PROPERTY OWNER INFORMATION (if diffe	E-Mail: ben.slotman@evlengineering.com
Phone #: (716) 699-9005 PROPERTY OWNER INFORMATION (if diffe Name: Mailing Address:	E-Mail: ben.slotman@evlengineering.com
Phone #: (716) 699-9005 PROPERTY OWNER INFORMATION (if diffe Name:	E-Mail: ben.slotman@evlengineering.com erent than Applicant) E-Mail:

### Current use of property: Municipal government - Town and Village offices

Description of Proposed Project/Use (attach additional pages, survey and plans): Replace existing front door and remove existing wall sign

Zoning Requirements from Town/Village Zoning I	Law	
Front yard setback: 10	Rear yard setback: 5	
Side yard setback: 0/25	Combined side: 0	-
Minimum lot size:	Width: 20	5
Height: 40	Floor area ratio: n/a	(Village)
Usable Open space: 20%		
Site Information		
Size of site: 18,600 Sq. Ft. Size of area to	o be developed: 0 Sq. Ft.	
Number of proposed lots: n/a		
Proposed method of Sanitary Sewage disposal: n/a	a	
Proposed method of Water Supply: n/a		
If public utilities are proposed, are they available to	o site?	
Sanitary Sewer: Yes No	Water: Yes No	
Will the project require the formation or extension		rict?
Sanitary Sewer: Yes No	Water: Yes No	
Main Structure:		
Construction type: Brick	Front yard setback: 75	feet
Height: 2stories, 47feet		feet
# of family units: n/a	Total of both side yard setbacks: 40	feet
Size of lot: <u>18,600</u> Sq. Ft.	Rear yard setback: 40	feet
Usable Open Space: 57% %	Floor area ratio: n/a	(village)
Corner or interior lot? Yes	Other:	
Accessory Building:		
Description:		
n/a		
Percentage of yard: n/a	Height: n/a feet	
Setback from rear lot line: n/a feet		feet
		2

revised through May 26, 2022

Floodplain:

FIRM Zone n/a	<sub>BFE</sub> n/a		_
Flood Plain Development Permit F	Required?	YES	NO

#### ATTACHMENTS

Attach all relevant items listed in the Town/Village of Ellicottville Zoning Law for type of application(s) being submitted. Additional copies of all plans, documents and other application materials may be required. See attached list of required forms and information needed for type of application being submitted. Deadline for submittal is three (3) weeks prior to regularly scheduled meeting date. Meeting dates are subject to change by the Board Chair.

#### SIGNATURES

Applicant and Owner (if different) must sign the application.

I hereby certify that I have examined this application and know the same to be true and correct. All provisions of laws and ordinances covering this type of work will be complied with whether specified herein or not. The acceptance or approval of this application does not presume to give authority to violate or cancel the provisions of any other state or local law regulating construction, land use or the performance of construction. I have read and am familiar with the Town/Village of Ellicottville zoning law that is relevant to this application(s).

Permission to inspect – I hereby consent to Town/Village of Ellicottville Staff inspection of the project site and adjacent property areas. Town/Village staff may enter the property without notice. Inspection may occur without the owner, applicant or agent present, If the property is posted with "keep out" signs or fenced with an unlocked gate, staff may still enter the property. Agency staff may take measurements, analyze site physical characteristics, take soil and vegetation samples, sketch and photograph the site.

Applicant Signature:	Van	Date:	1/29/2027
Applicant must be (check all that apply):	Owner	Operator	Lessee
Applicant Name: <sup>Print</sup> Town of Ellicottville			

Property Owner's Signature (if different than applicant)

Property Owner's Name: Print

Office use only:		
Application Fee(s)		
Received by:	on	(Date)
Project Number(s):		

revised through May 26, 2022

Date:

# TOWN HALL ELLICOTTVILLE

TOWN OF ELLICOTVILLE PROJECT NO. 00410 CONSTRUCTION DOCUMENT PHASE SUBMISSION DATE: JANUARY 25, 2024

> FLYNN BATTAGLIA ARCHITECTS 617 Main Street, Suite 401 Buffalo, New York 14203 Telephone (716) 854-2424

## **REFERENCE SYSTEMS**


SYMBOLS LEGEND				
SEE DISCIPLINE SH	IEETS FOR DISCIPLINE	SPECIFIC SYMBOLS		
N	NORTH ARROW		XTERIOR LEVATION NO. EXTERIOR ELEVATION	
0	GRID LINE	DETAIL 4 A211 2		
Room Name	ROOM No.	SHEET 3 DETAIL	INTERIOR ELEVATION	
	DOOR No.	SHEET	-BUILDING SECTION	
	WINDOW/ STOREFRONT/	DETAIL 1 SHEET A301	-WALL SECTION	
A02	LOUVER TYPE	DETAIL 1 SHEET	DETAIL	
000	SPECIALTY EQUIPMENT / FURNITURE TAG		SPOT ELEVATION MARKERS H CURRENT DWG. W/	
1	SCOPE NOTE	/ COMP	THIS DWG. TO LETE FLOOR PLAN, TION OR SECTION	
ę	CENTER LINE	1 / A101	MATCHLINE	
	REVISION No.		ISIM	
	) REVISION CLOUD		ENLARGED PLAN MARKER	
	FLOW ARROW	AREA INCLUDED IN LARGE SCALE BLOW-UP OF PLAN		
GYP BD 10'-0" AFF	CEILING TAG	BEOM OF OF FEAR		

# **KEY TO MATERIALS**

MATERIALS LEGEND

ALL MATERIALS AS SHOWN UNLESS OTHERWISE NOTED				
	ALUMINUM			
	CONCRETE			
	GLASS			
	RIGID INSULATION			
	BRICK IN SECTION			
	CONCRETE MASONRY UNIT			
	EARTH			
$ \begin{array}{c} \sum\limits_{i=1}^{n} \sum\limits_{j=1}^{n} \sum\limits_{i=1}^{n} \sum\limits_{i=1}^{n} \sum\limits_{j=1}^{n} \sum\limits_{i=1}^{n} \sum\limits_{i=1}^{n} \sum\limits_{j=1}^{n} \sum\limits_{i=1}^{n} \sum\limits\limits_{i=1}^{n} \sum \sum\limits\limits_{i=1}^{n} \sum \sum\limits\limits_{i=1}^{n} \sum\limits\limits_{i=1}^{n} \sum\limits\limits_{i=1}^{n} \sum\limits\limits_{$	GYPSUM / PLASTER			
	STEEL			
RESER	PEA GRAVEL			
	STONE			
	BATT INSULATION			
× k	PRECAST			
	GRAVEL			
	GRAVEL SAND			
	SAND			
	SAND WOOD - SOLID			
	SAND WOOD - SOLID PLYWOOD			
	SAND WOOD - SOLID PLYWOOD BRICK			
	SAND WOOD - SOLID PLYWOOD BRICK CULTURED STONE EXTERIOR COMPOSITE			
	SAND WOOD - SOLID PLYWOOD BRICK CULTURED STONE EXTERIOR COMPOSITE PANEL			
	SAND WOOD - SOLID PLYWOOD BRICK CULTURED STONE EXTERIOR COMPOSITE PANEL WOOD BLOCKING			


### **DRAWING LIST**

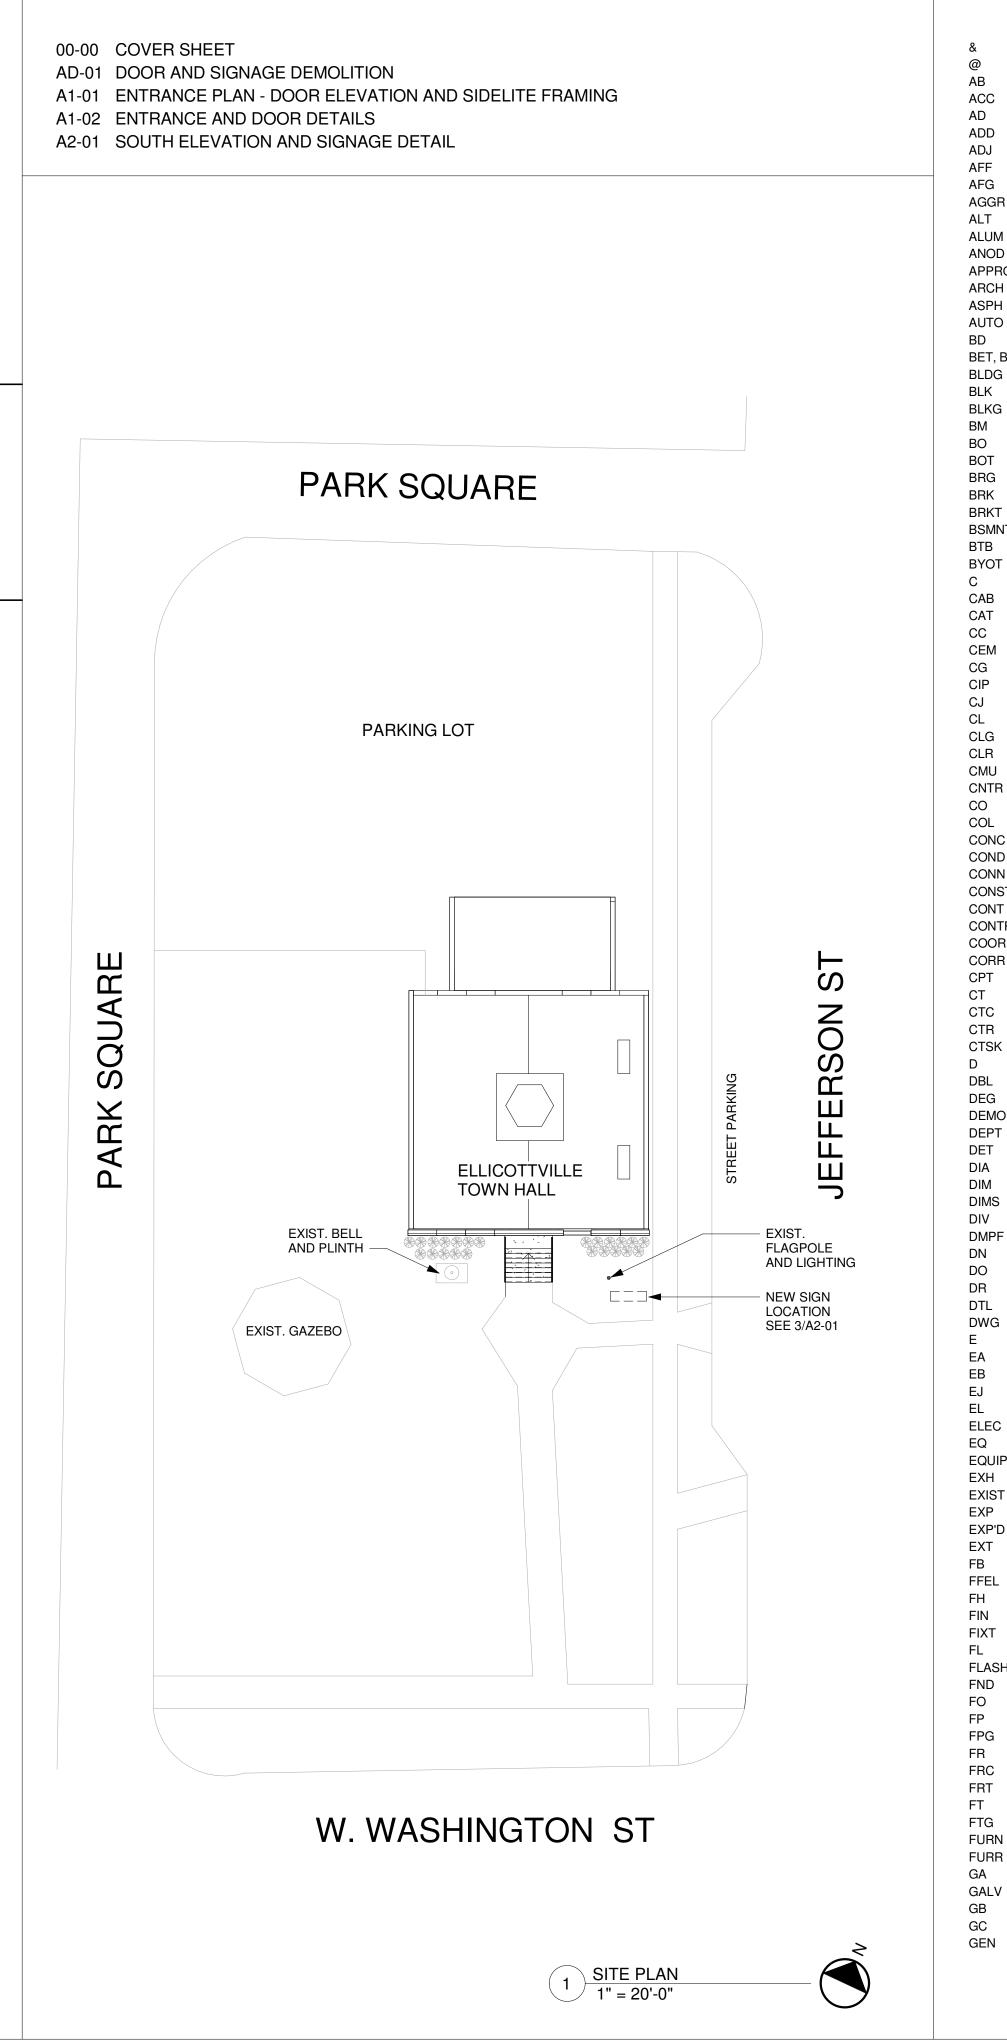

AND AT AN ADD ADJ AFF AFG AGGR ALT ALUM ANOD APPROX ARCH ASPH AUTO BET, BTW BLDG BLK BLKG BOT BRG BRK BRKT BSMNT BTB BYOT С C CI CMU CC CNTR С COL CONC COND CONN CC CONST CC CONT CC CONTR CC COORD CC CORR CE CTC CE CTR CF CTSK CC DE DBL DEG DE DEMO DE DEPT DE DE DI DI DIMS DI DI DMPF DA DC DC DC DE DWG DF E EA Ε> EL ELEC EL E EQUIP EXIST EXP'D E FA FFEL FI FI FI FI FLASH FI FC FURN FL FURR FL G/ G/

### ABBREVIATIONS

AND AT	GL GLAZ	GLASS GLAZING	SAF SC	SELF ADHERED FLASHING SOLID CORE
ANCHOR BOLT	GRD	GROUND	SCHED	SCHEDULE
ACCESSIBLE	GRFG	GLASS FIBER REINFORCED GYPSUM	SD	STORM DRAIN
ACCESS DOOR	GSM	GALVANIZED SHEET METAL	SE	SOUTHEAST
ADDENDUM	GV	GAS VALVE	SECT	SECTION
	GWB	GYPSUM WALL BOARD	SF	SQUARE FEET/FOOT
ABOVE FINISHED FLOOR ABOVE FINISHED GRADE	GYP H	GYPSUM HIGH/HEIGHT	SHT SIM	SHEET SIMILAR
AGGREGATE	HC	HANDICAPPED	SIM	SHEET METAL
ALTERNATE	HDW	HARDWARE	SM	SURFACE MOUNTED
ALUMINUM	HDWD	HARDWOOD	SNT	SEALANT
ANODIZED	HM	HOLLOW METAL	SP	STANDPIPE
APPROXIMATE	HNDRL	HANDRAIL	SPEC	SPECIFIED OR SPECIFICATION
ARCHITECTURAL	HORIZ	HORIZONTAL	SQ	SQUARE
ASPHALT	HP	HIGH POINT	SS	STAINLESS STEEL
AUTOMATIC BOARD	HT ID	HEIGHT INSIDE DIAMETER	STD STL	STANDARD STEEL
BETWEEN	IGU	INSULATED GLASS UNIT	STRG	STRINGER
BUILDING	IN	INCH/INCHES	STRUCT	STRUCTURE OR STRUCTURAL
BLOCK	INCL	INCLUDED/INCLUDING	SUBCAT	SUBCATEGORY
BLOCKING	INFO	INFORMATION	SUSP	SUSPENDED
BEAM	INSUL	INSULATION OR INSULATED	SW	SOUTHWEST
BOTTOM OF	INT	INTERIOR	SYM	SYMMETRICAL
BOTTOM BEARING	INTERM INV	INTERMEDIATE INVERT	SYS T	SYSTEM TREAD
BRICK	JST	JOIST	T&B	TOP AND BOTTOM
BRACKET	JT	JOINT	T&G	TONGUE AND GROOVE
BASEMENT	KO	KNOCK OUT	TEMP	TEMPORARY
BACK-TO-BACK MOUNTING	LAM	LAMINATED	ТН	THICKNESS
BY OTHERS	LAR	LENGTH AS REQUIRED	THR	THRESHOLD
CHANNEL	LB	POUNDS	THRU	THROUGH
CABINET	LDW	LESS THAN DOOR WIDTH	TMPD	TEMPERED
CATEGORY CENTER TO CENTER	LF LT	LINEAR FEET LIGHT	TO TOB	TOP OF TOP OF BEAM
CEMENT	LI LWT	LIGHT	TOB	TOP OF BEAM TOP OF CONCRETE
CORNER GUARD	MANUF	MANUFACTURER	TOC	TOP OF STEEL
CAST-IN-PLACE	MAS	MASONRY	TS	TUBE STEEL
CONTROL JOINT	MATL	MATERIAL	TYP	TYPICAL
CENTERLINE	MAX	MAXIMUM	UNFIN	UNFINISHED
CEILING	MECH	MECHANICAL	UNO	UNLESS NOTED OTHERWISE
CLEAR	MED	MEDIUM	UON	UNLESS OTHERWISE NOTED
CONCRETE MASONRY UNIT	MEMBR MIN	MEMBRANE		VENTILATION AND AIR CONDITIONING
COUNTER CLEANOUT	MISC	MINIMUM MISCELLANEOUS	VAR VB	VARIES VAPOR BARRIER
COLUMN	MO	MASONRY OPENING	VCT	VINYL COMPOSITION TILE
CONCRETE	MR	MOISTURE RESISTANT	VERT	VERTICAL
CONDITION	MTD	MOUNTED	VEST	VESTIBULE
CONNECTION	MTG	MOUNTING	VIF	VERIFY IN FIELD
CONSTRUCTION	MTL	METAL	VP	VISION PANEL
CONTINUOUS	MULL	MULLION	VR	VAPOR RETARDER
CONTRACTOR	N		VT	
COORDINATE CORRIDOR	NA NIC	NOT APPLICABLE NOT IN CONTRACT	W W/	WIDE/WEST WITH
CARPET	NO	NUMBER	W/O	WITHOUT
CERAMIC TILE	NOM	NOMINAL	WD	WOOD
CENTERLINE TO CENTERLINE	NON COMB	NON COMBUSTIBLE	WIN	WINDOW
CENTER	NTS	NOT TO SCALE	WP	WATERPROOF/WATERPROOFING
COUNTERSUNK	NW	NORTHWEST	WPM	WATERPROOF MEMBRANE
DEEP, DEPTH	OC	ON CENTER	WS	WEATHER-STRIPPING
DOUBLE	OD	OUTSIDE DIAMETER	WT	WEIGHT
DEGREE DEMOLISH OR DEMOLITION	OFCI	OWNER FURNISHED, CONTRACTOR INSTALLED		
DEPARTMENT	OFF	OFFICE		
DETAIL	OFOI	OWNER FURNISHED, OWNER INSTALLED		
DIAMETER	OH	OPPOSITE HAND		
DIMENSION	OPNG	OPENING		
DIMENSIONS	OPP	OPPOSITE		
DIVISION	OVR	OVERHEAD		
DAMP PROOFING	PAV PC	PAVING PRECAST		
DOWN DOOR OPENING	PERIM	PERIMETER		
DOOR	PERP	PERPENDICULAR		
DETAIL	PI.	PLATE		
DRAWING	PLAS	PLASTER		
EAST	PLBG	PLUMBING		
EACH	PLF	POUNDS PER LINEAR FOOT		
EXPANSION BOLT	PLYWD			
EXPANSION JOINT	PNL PNT	PANEL PAINT OR PAINTED		
ELEVATION ELECTRICAL	POL	PAINT OR PAINTED POLISHED		
ELECTRICAL	POL	PAIR		
EQUIPMENT	PREFAB	PREFABRICATED		
EXHAUST	PROJ	PROJECT		
EXISTING	PSF	POUNDS PER SQUARE FOOT		
EXPANSION	PT	PRESSURE TREATED		
EXPOSED	PTN			
EXTERIOR	PVC QTY			
	QIY R	QUANTITY RADIUS/RISER		
FINISH FLOOR ELEVATION FLAT HEAD	RAD	RADIUS		
FINISH	RB	RESILIENT BASE		
FIXTURE	RBR	RUBBER		
FLOOR	REC	RECESSED		
FLASHING	REF	REFERENCE		
FOUNDATION				
	REINF REL	REINFORCED/REINFORCING RELOCATE		
		REMOVABLE		
FIRE PROTECTION	REM			
FIRE PROTECTION FIREPROOFING	REM REOOM	RECOMMENDED		
FIRE PROTECTION		REQUIRE/REQUIRED		
FIRE PROTECTION FIREPROOFING FIRE RESISTANT	REOOM			
FIRE PROTECTION FIREPROOFING FIRE RESISTANT FIBER REINFORCED CONCRETE	REOOM REQ RESIL REV	REQUIRE/REQUIRED RESILIENT REVISION/REVISED		
FIRE PROTECTION FIREPROOFING FIRE RESISTANT FIBER REINFORCED CONCRETE FIRE RETARDANT TREATED FEET/FOOT FOOTING	REOOM REQ RESIL REV RM	REQUIRE/REQUIRED RESILIENT REVISION/REVISED ROOM		
FIRE PROTECTION FIREPROOFING FIRE RESISTANT FIBER REINFORCED CONCRETE FIRE RETARDANT TREATED FEET/FOOT FOOTING FURNITURE	REOOM REQ RESIL REV RM RND	REQUIRE/REQUIRED RESILIENT REVISION/REVISED ROOM ROUND		
FIRE PROTECTION FIREPROOFING FIRE RESISTANT FIBER REINFORCED CONCRETE FIRE RETARDANT TREATED FEET/FOOT FOOTING FURNITURE FURRING	REOOM REQ RESIL REV RM RND RO	REQUIRE/REQUIRED RESILIENT REVISION/REVISED ROOM ROUND ROUGH OPENING		
FIRE PROTECTION FIREPROOFING FIRE RESISTANT FIBER REINFORCED CONCRETE FIRE RETARDANT TREATED FEET/FOOT FOOTING FURNITURE FURRING GAUGE	REOOM REQ RESIL REV RM RND RO ROW	REQUIRE/REQUIRED RESILIENT REVISION/REVISED ROOM ROUND ROUGH OPENING RIGHT OF WAY		
FIRE PROTECTION FIREPROOFING FIRE RESISTANT FIBER REINFORCED CONCRETE FIRE RETARDANT TREATED FEET/FOOT FOOTING FURNITURE FURRING GAUGE GALVANIZED	REOOM REQ RESIL REV RM RND RO ROW RTD	REQUIRE/REQUIRED RESILIENT REVISION/REVISED ROOM ROUND ROUGH OPENING RIGHT OF WAY RATED		
FIRE PROTECTION FIREPROOFING FIRE RESISTANT FIBER REINFORCED CONCRETE FIRE RETARDANT TREATED FEET/FOOT FOOTING FURNITURE FURRING GAUGE	REOOM REQ RESIL REV RM RND RO ROW	REQUIRE/REQUIRED RESILIENT REVISION/REVISED ROOM ROUND ROUGH OPENING RIGHT OF WAY		

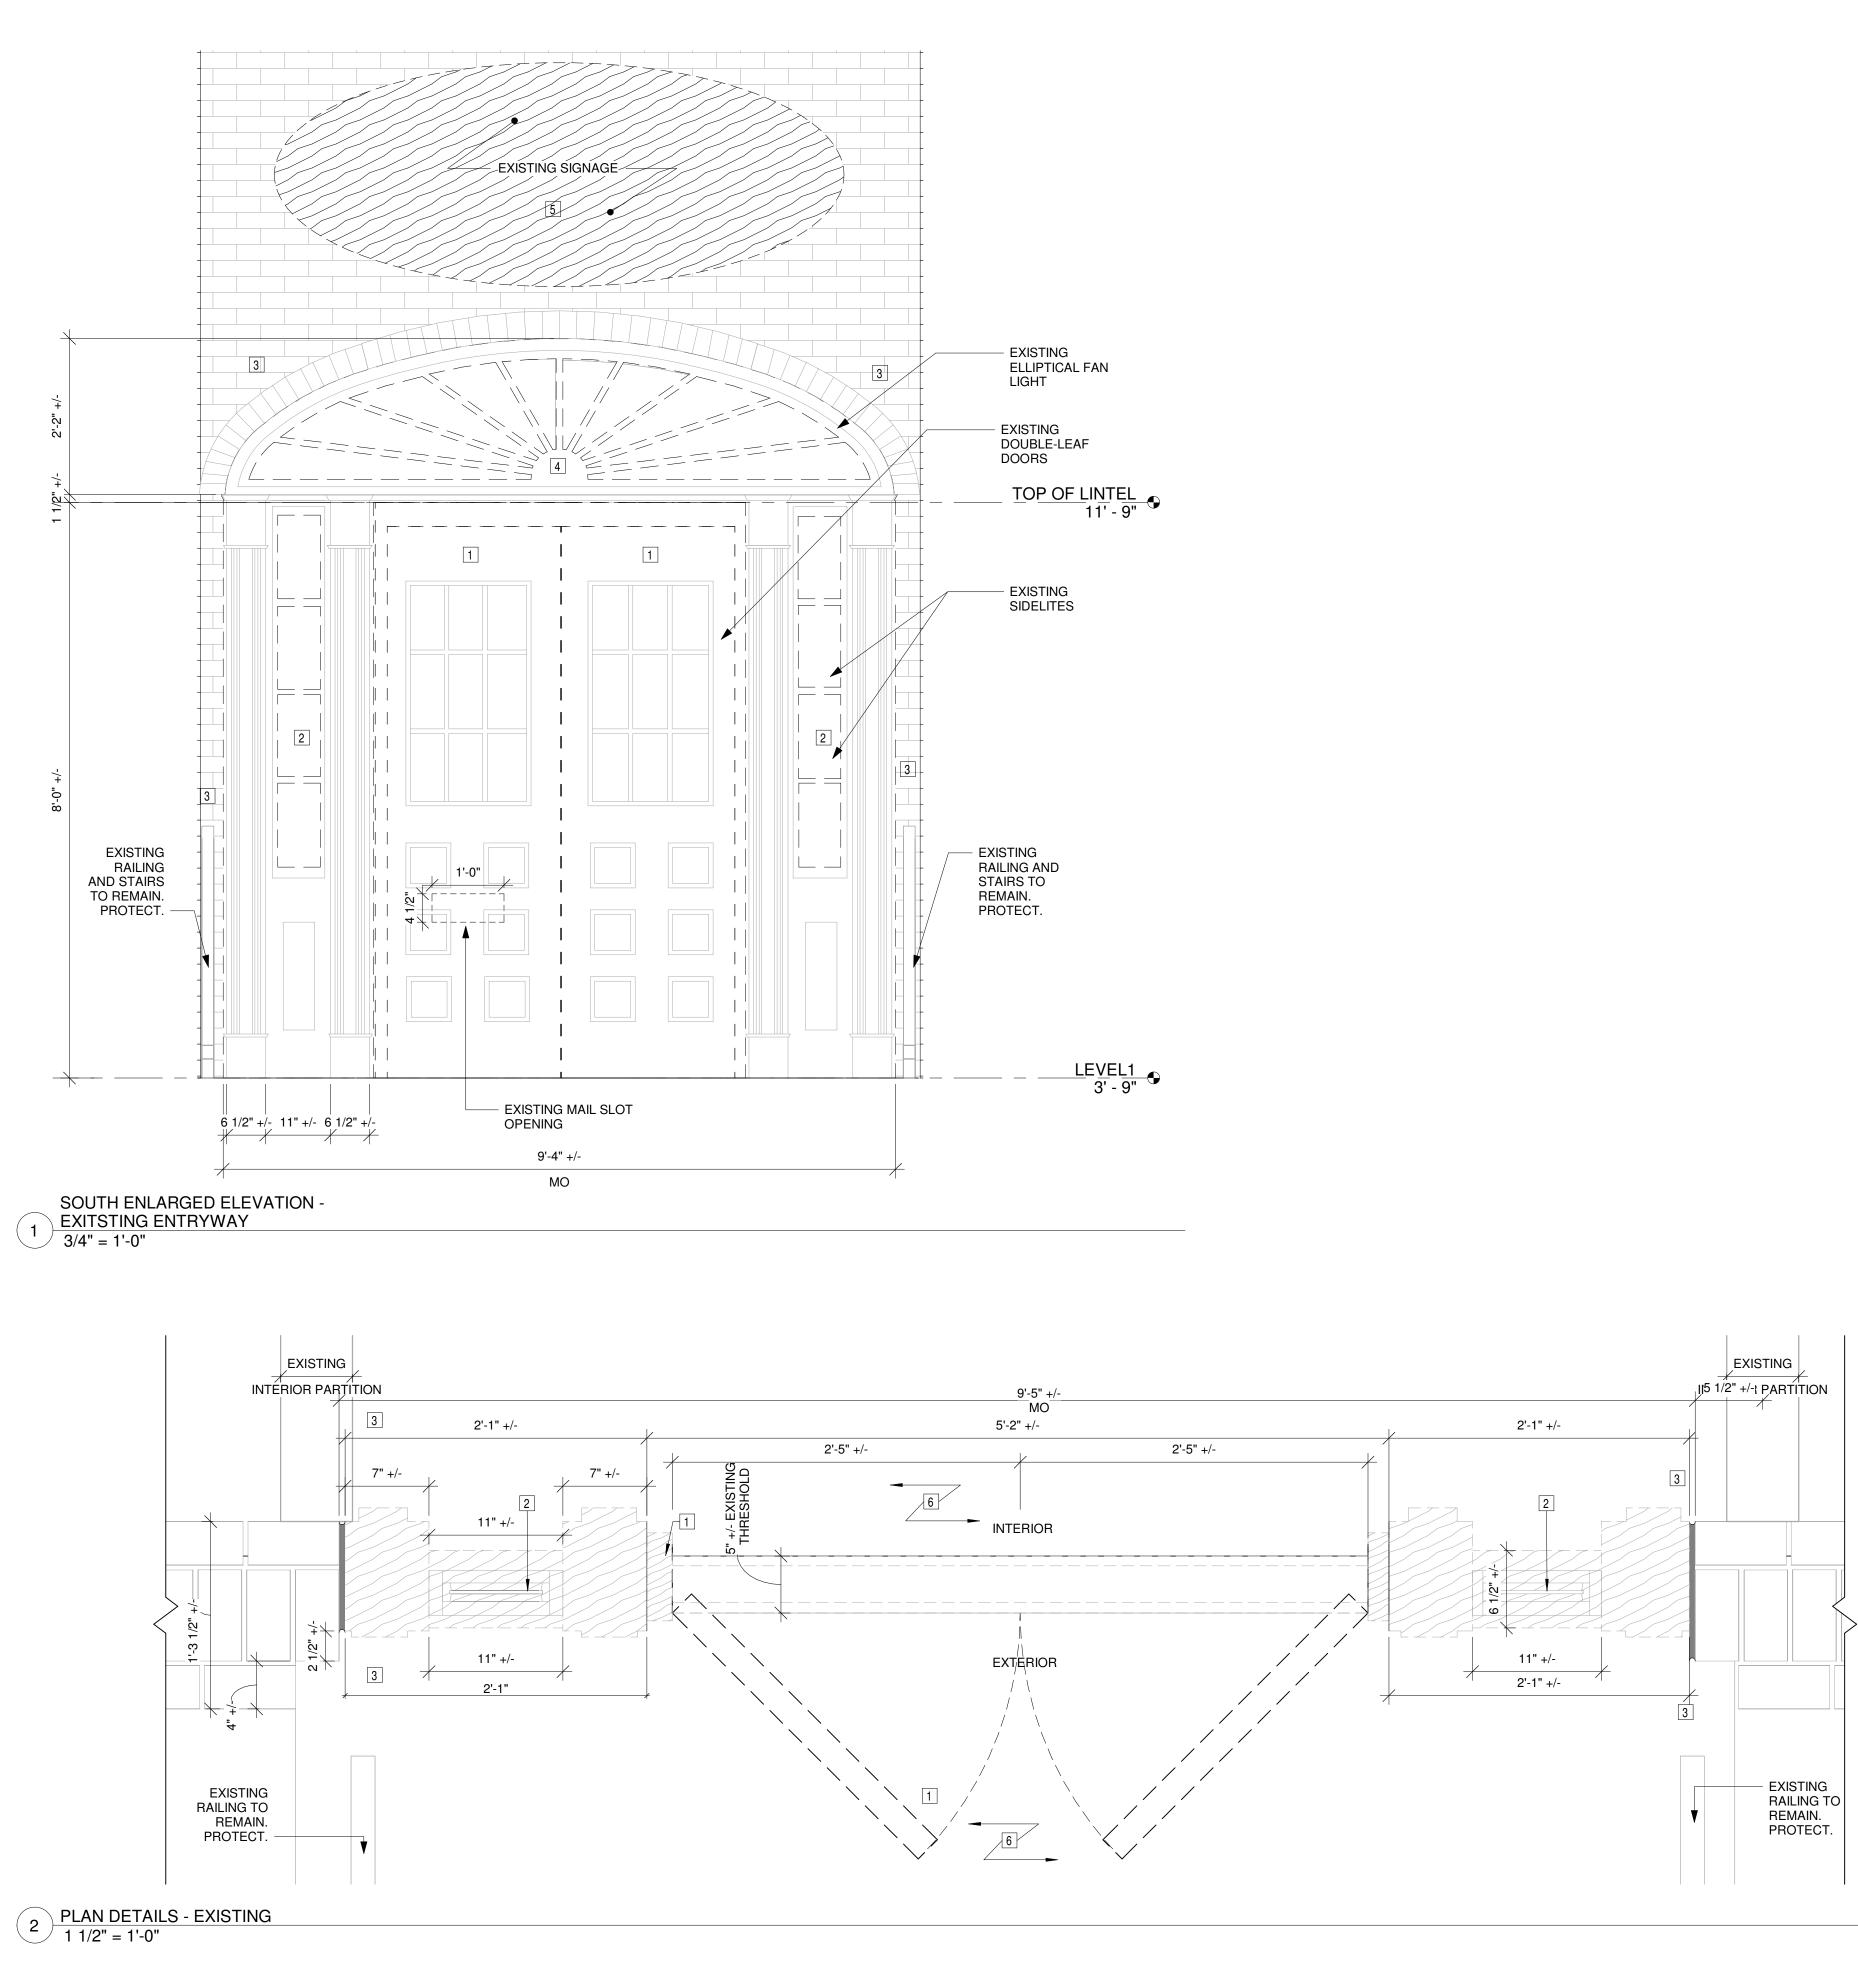

1. REFER TO ALL DRAWINGS, SPECIFICATIONS AND REFERENCED FIELD CONDITIONS TO DETERMINE FULL SCOPE AND PARTICULARS OF REMOVAL REQUIREMENTS PRIOR TO CONSTRUCTION 2. QUANTITIES AND DIMENSIONS SHOWN ON THIS DRAWING ARE BASED ON FIELD OBSERVATION AND ARE INTENDED TO SERVE AS ORDER OF MAGNITUDE INDICATIONS OF WORK. ACTUAL REQUIREMENTS MAY VARY. VERIFY ALL DIMENSIONS IN FIELD BEFORE PROCEEDING WITH WORK. NOTIFY ARCHITECT IF EXISTING CONDITIONS OCCUR DIFFERENTLY THAN DOCUMENTED.

COMPLETE.

3. PROTECT INTERIOR AND EXTERIOR EXISTING WALL TO REMAIN. 4. REMOVE EXISTING ELLIPTICAL FAN WINDOW, FRAME AND TRIM COMPLETE.

5. REMOVE EXISTING SIGNAGE AND ATTACHMENTS, COMPLETE. 6. PROTECT EXISTING FLOORING DURING CONSTRUCTION.

### **GENERAL DEMO NOTES**

3. ALL DIMENSIONS ARE +/- AND ARE TO BE VERIFIED IN FIELD BEFORE PROCEEDING WITH WORK.

4. RESTORE ALL EXIST. CONDITIONS DAMAGED DURING REMOVAL WORK AND NOT SCHEDULED TO BE REMOVED TO MATCH EXIST. CONDITIONS. ALL AREAS REQUIRING CUTTING AND PATCHING SHALL BE FINISHED TO MATCH ADJACENT SURFACES UNLESS NOTED OTHERWISE.


5. UNLESS OTHERWISE NOTED, ALL REMOVALS IDENTIFIED IN THESE NOTES BECOME PROPERTY OF THE CONTRACTOR MAKING THE REMOVAL.


6. DURING REMOVAL OPERATIONS, HAVE SUFFICIENT AND SUITABLE MATERIALS ON-SITE TO FACILITATE RAPID INSTALLATION OF TEMPORARY PROTECTION IN THE EVENT OF INCLEMENT WEATHER.

### SPECIFIC DEMO NOTES


1. REMOVE EXISTING DOOR, FRAME, TRIM AND HARDWARE,


2. CONTRACTOR TO REMOVE EXISTING DOOR SIDELIGHT AND TRANSOM COMPLETE IN AREA IDENTIFIED ON PLAN. PATCH AND REPAIR EXISTING WALL AND ADJACENT FINISHES TO REMAIN TO MATCH EXISTING. PATCH AND REPAIR FLOOR TO MATCH ADJACENT.

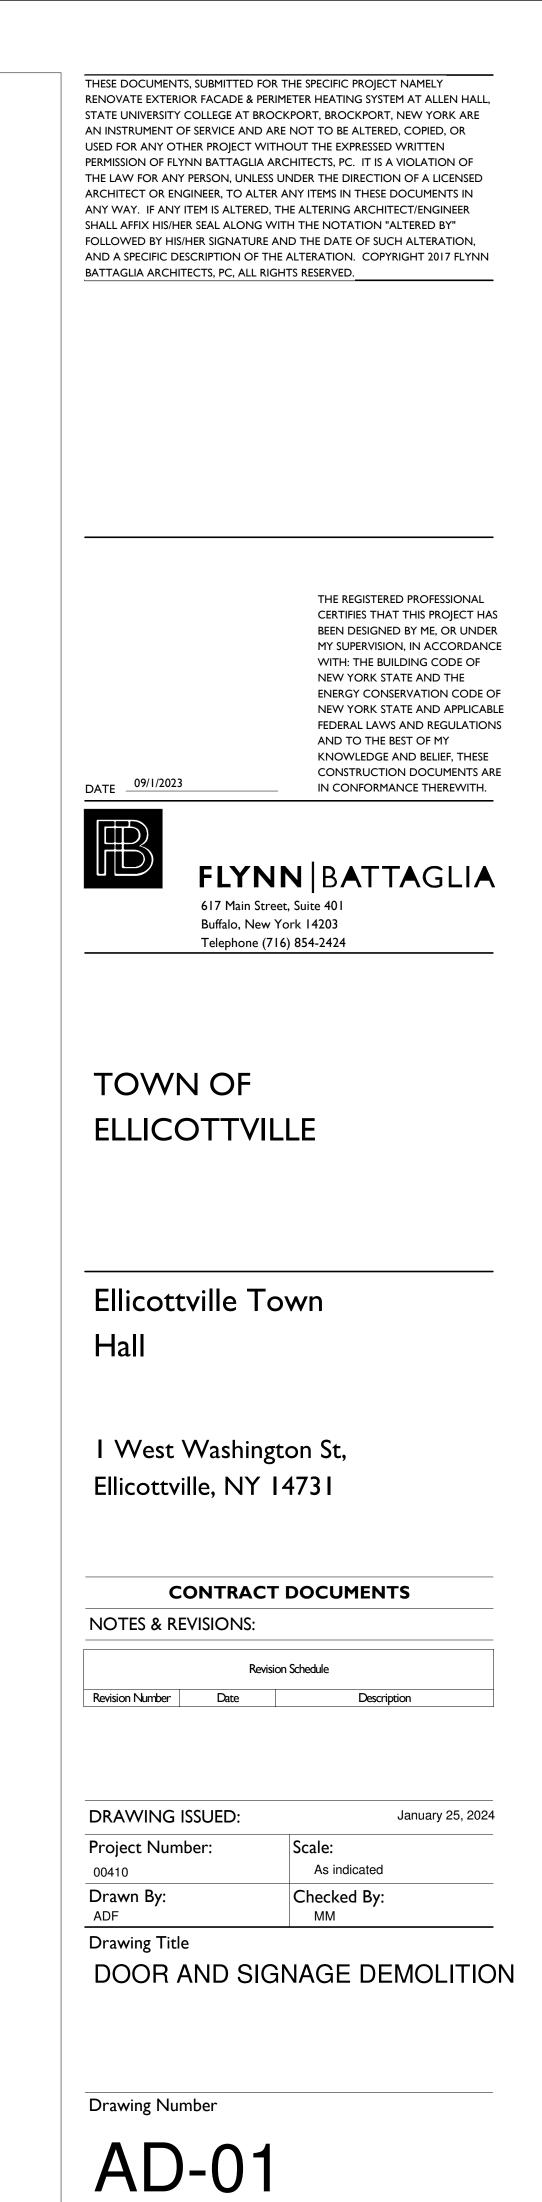


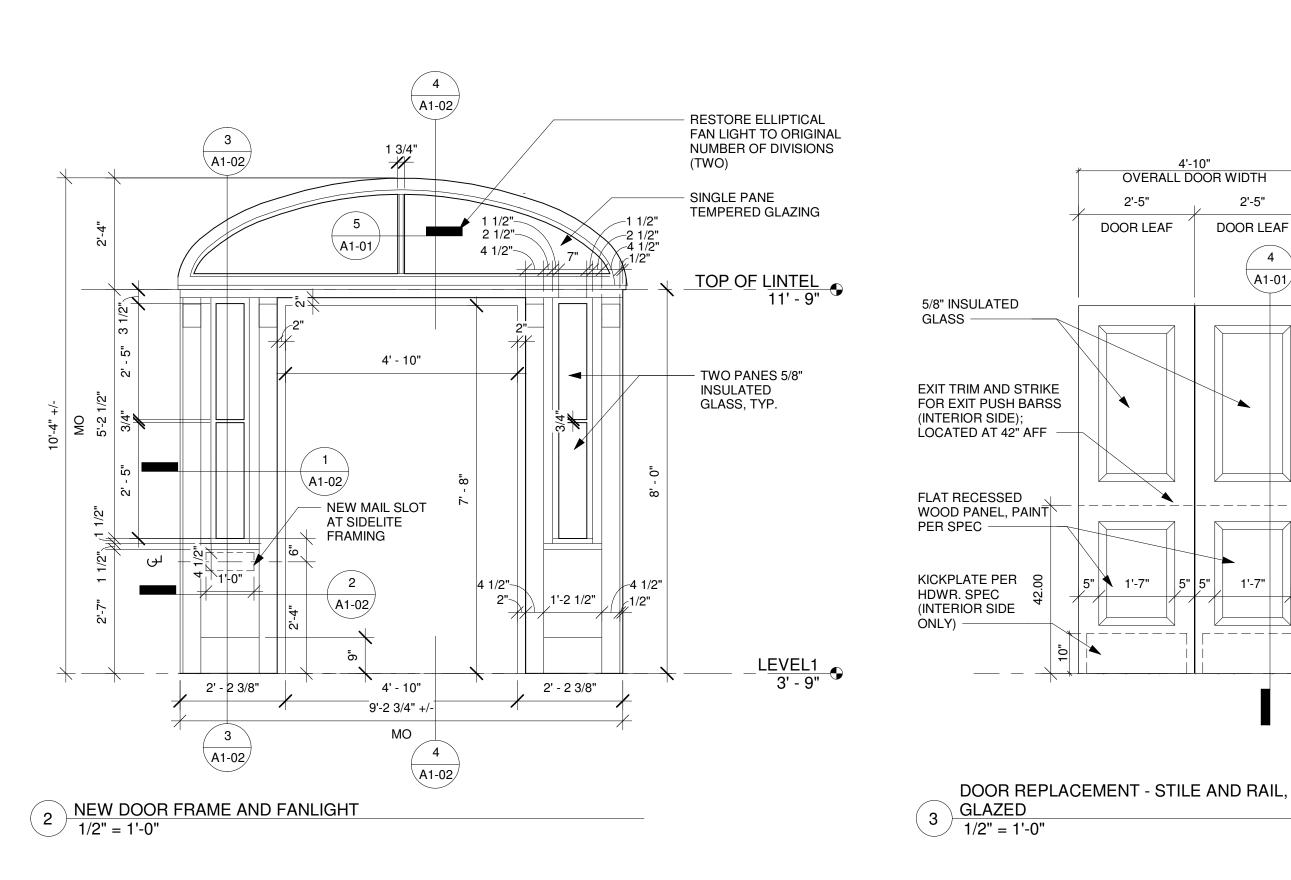



1 PLAN DETAILS - NEW 1 1/2" = 1'-0"

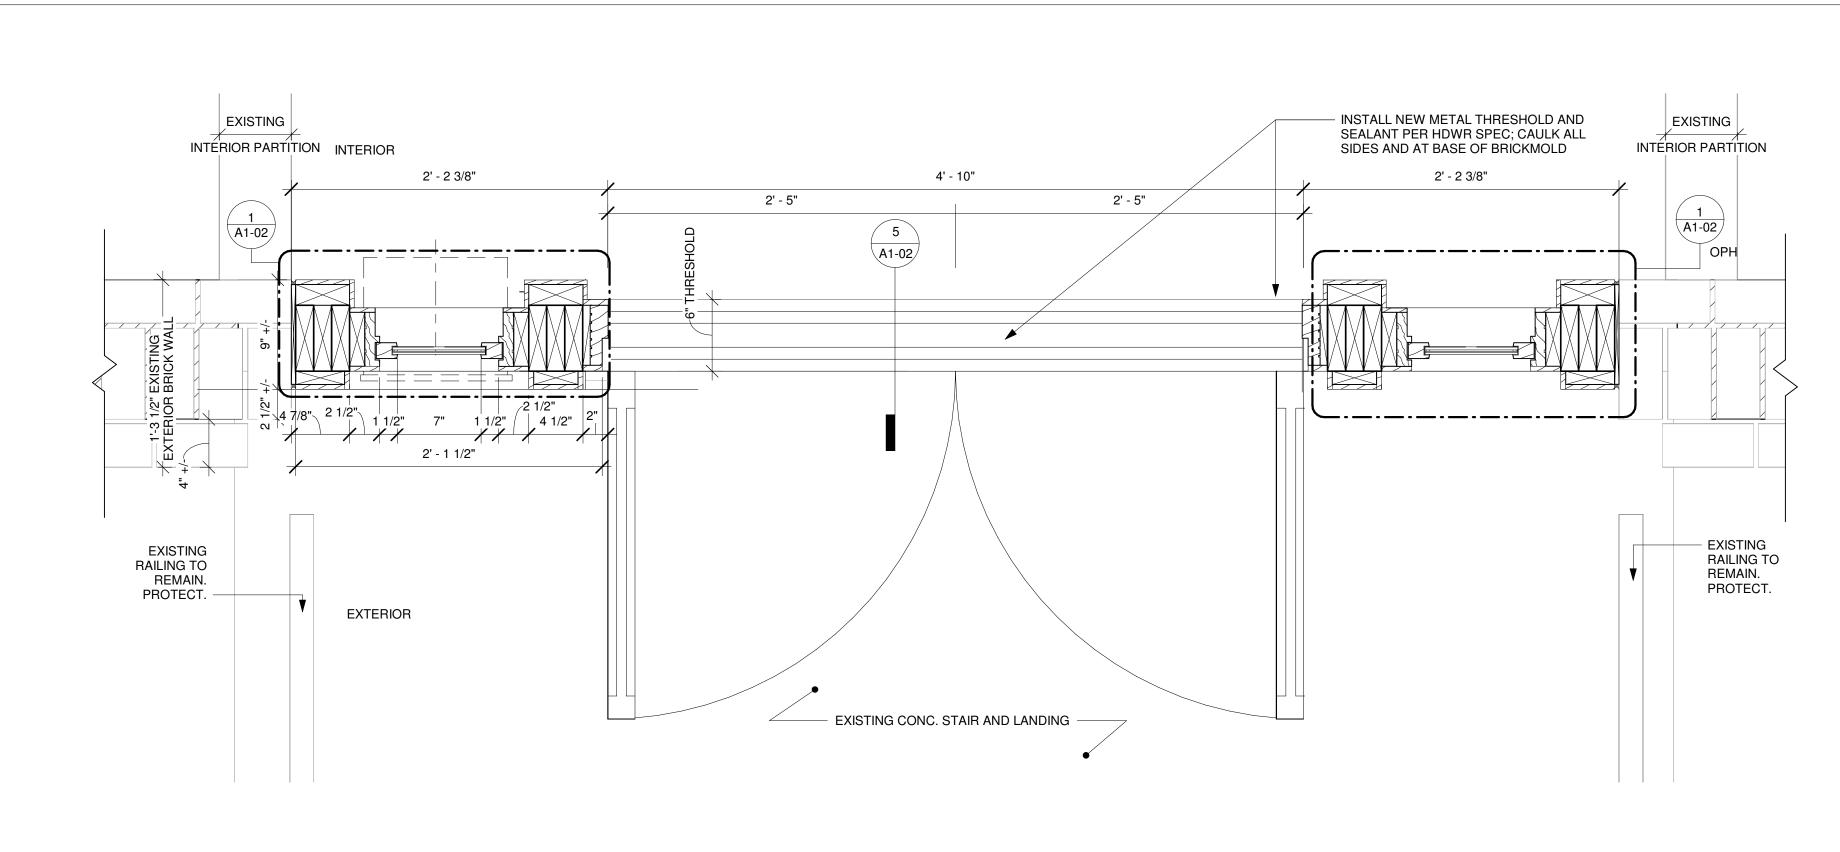

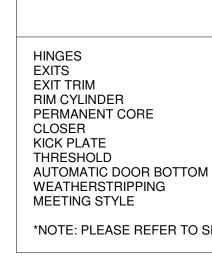

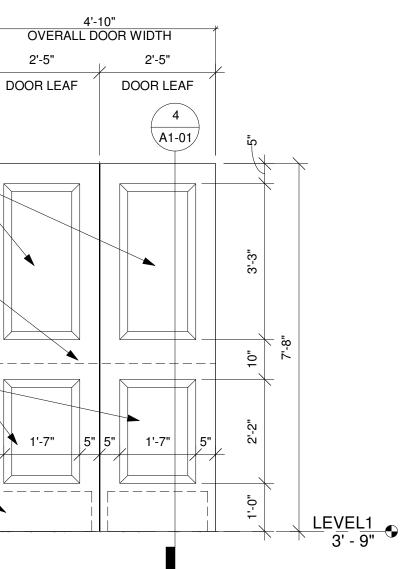

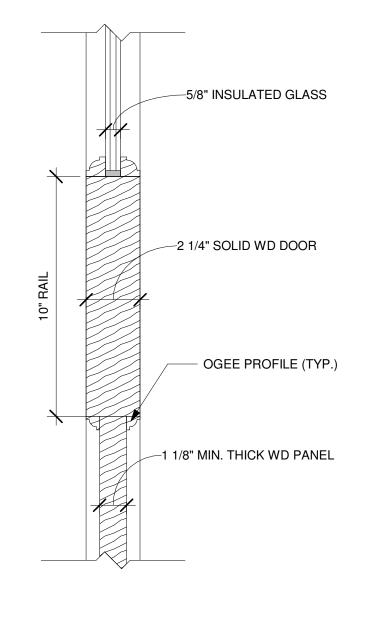

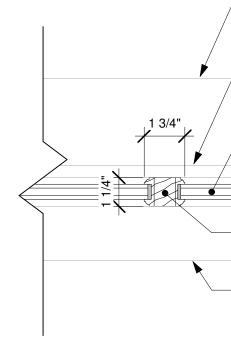

4 DOOR DETAILS - STILE AND RAIL 3" = 1'-0"



### **GENERAL NOTES**

1. QUANTITIES AND DIMENSIONS SHOWN ON THIS DRAWING ARE BASED ON FIELD OBSERVATION AND ARE INTENDED TO SERVE AS ORDER OF MAGNITUDE INDICATIONS OF WORK. ACTUAL REQUIREMENTS MAY VARY. VERIFY ALL DIMENSIONS IN FIELD BEFORE PROCEEDING WITH WORK. NOTIFY ARCHITECT IF EXISTING CONDITIONS OCCUR DIFFERENTLY THAN DOCUMENTED.

2. ALL DIMENSIONS ARE +/- AND ARE TO BE VERIFIED IN FIELD BEFORE PROCEEDING WITH WORK.

3. UNLESS OTHERWISE NOTED, ALL REMOVALS IDENTIFIED IN THESE NOTES BECOME PROPERTY OF THE CONTRACTOR MAKING THE REMOVAL.

4. COORDINATE ALL WORK INDICATED ON THIS DRAWING WITH THAT OF THE OTHER TRADES.


5. ALL FINISH COLORS TO BE SELECTED BY ARCHITECT FROM SUBMITTALS BY CONTRACTOR FOR SPECIFIED PRODUCTS.

6. RESTORE SITE TO ORIGINAL CONDITIONS AS FOUND.

### HARDWARE SCHEDULE

QTY	TYPE	FINISH	MFR (BASIS OF DESIGN)
8 2 2 2 2 2 2 1 2 1 2 1 2	5" X 5" BB1199 NRP BALL TIP 8827TP ER12 X LAR 880TP-V 3216 CONSULT OWNER 5100 HDCS 190S 10" X 2" LDW 422S X LAR 743S N X LAR 860SW X LAR 771SW X LAR	US10 US10 US10 US10 MIL MIL PTM MIL	HA VD VD BYOT HA HA HA HA HA HA

\*NOTE: PLEASE REFER TO SPEC SECTION 08 71 00 DOOR HARDWARE FOR ADDITIONAL INFORMATION

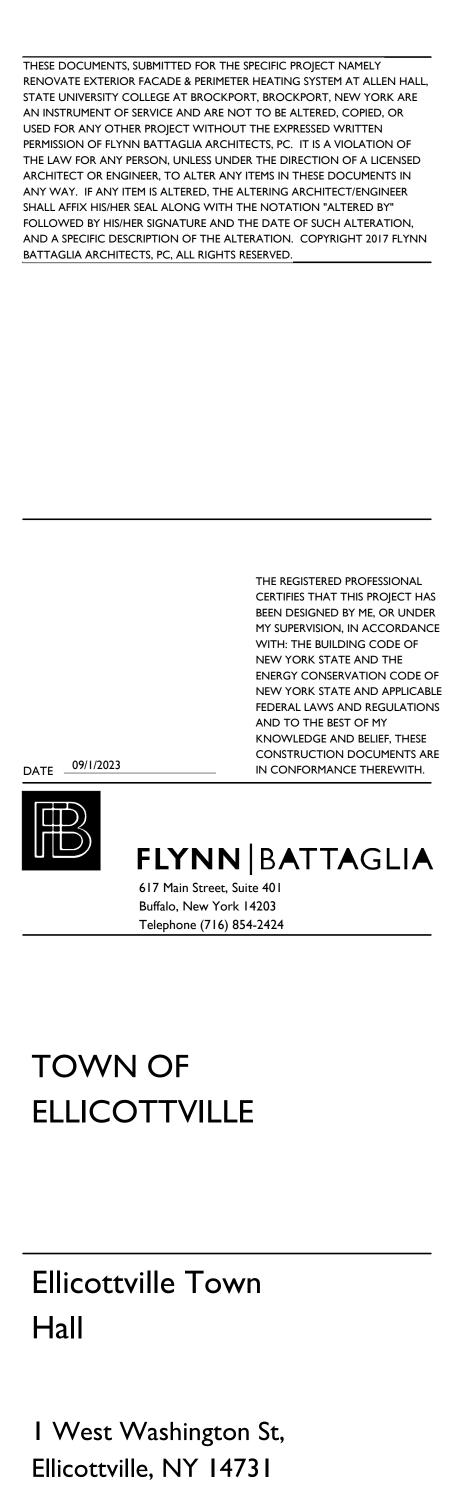

I West Washington St,
Ellicottville, NY 14731
CONTRACT DOCUMENTS
NOTES & REVISIONS:

**Revision Schedule** Revision Number Date

Description

January 25, 2024

DRAWING ISSUED:

Project Number: 00410 Drawn By:

Scale: As indicated Checked By: MM

Drawing Title

ADF

ENTRANCE PLAN - DOOR ELEVATION AND SIDELITE FRAMING

Drawing Number


A1-01

LINE OF RADIUSED WINDOW FRAME (ABOVE) - LINE OF WD STOP (ABOVE) 5/8" LAMINATED


GLASS, TYP.

WD MUNTIN WITH OGEE PROFILE, TYP.


LINE OF RADIUSED WINDOW FRAME (ABOVE)

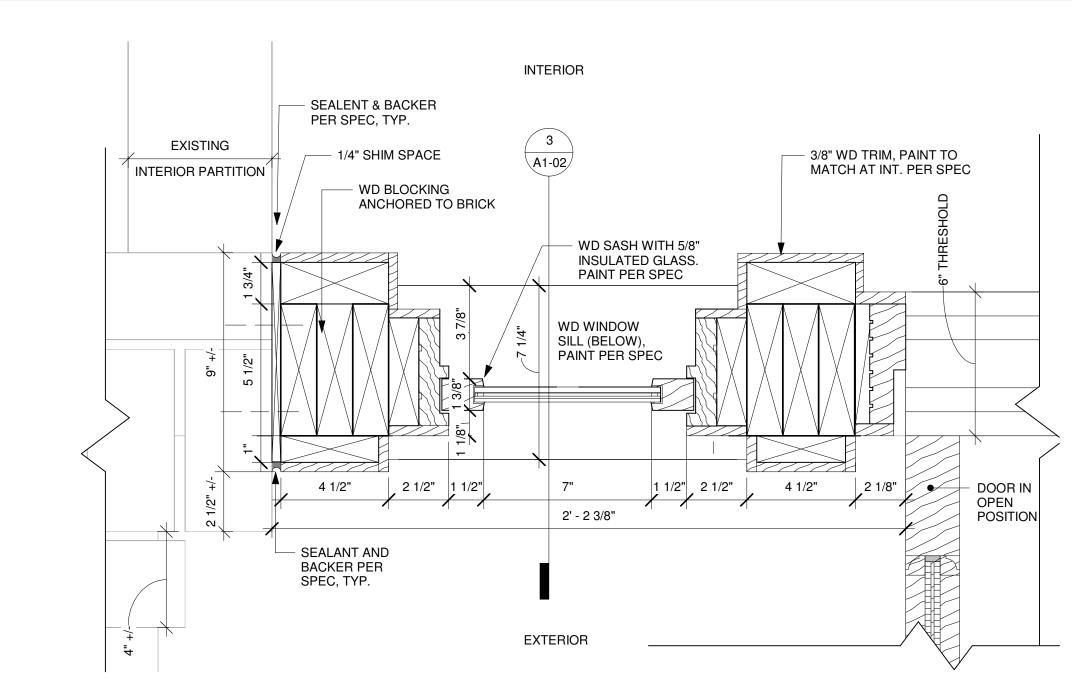




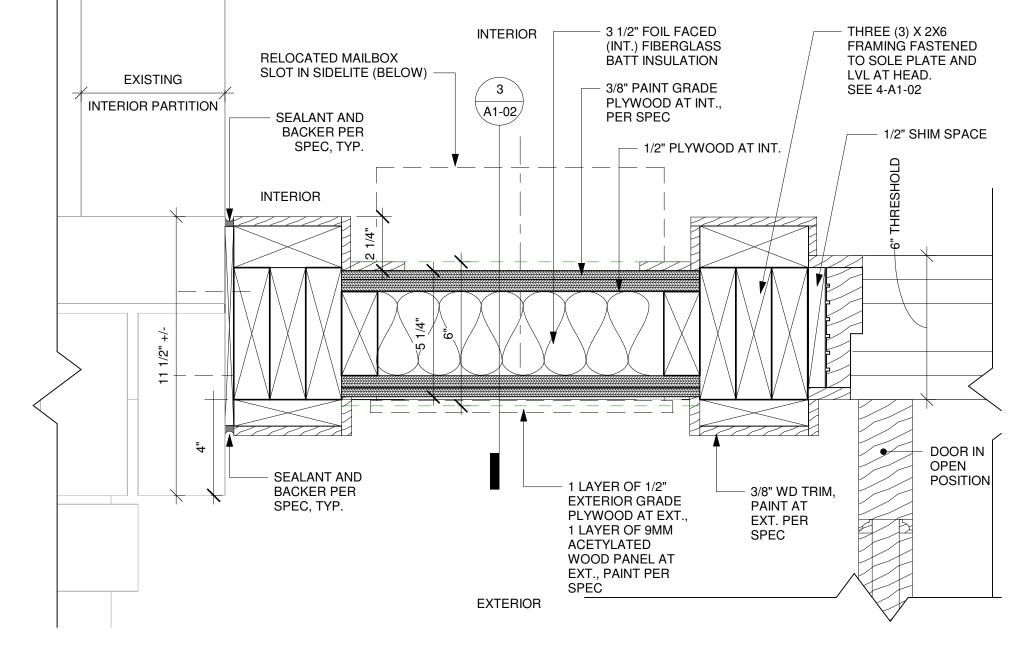


2 PLAN DETAILS - AT SIDELITE FRAMING 3" = 1'-0"

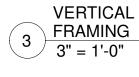


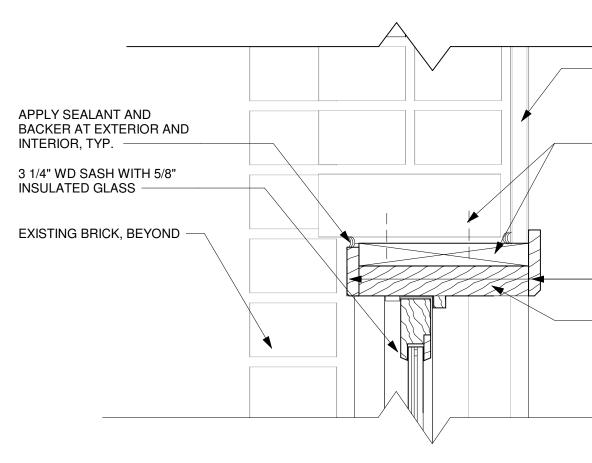



EXT

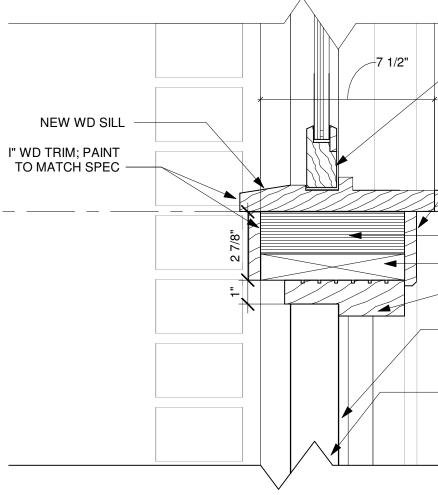



VERTICAL SECTION DETAIL - DOOR HEADER AND FANLIGHT 3" = 1'-0"

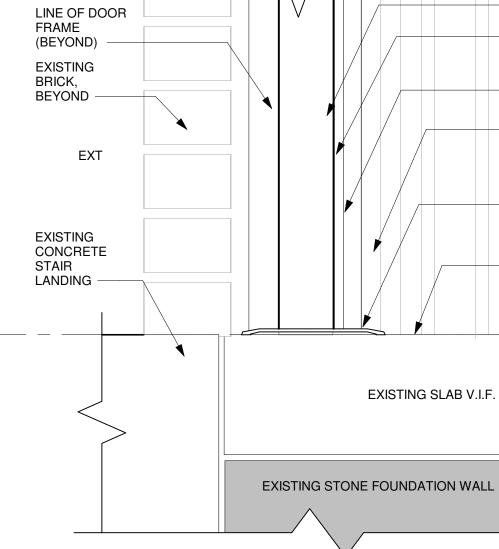


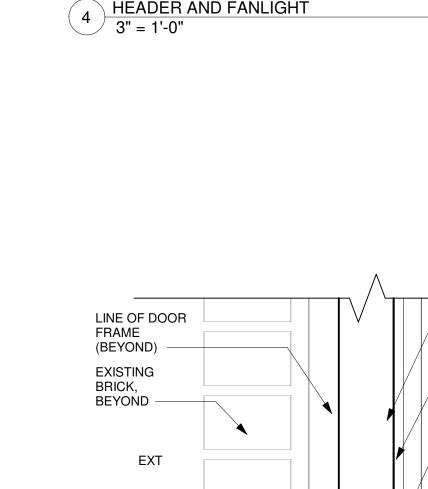

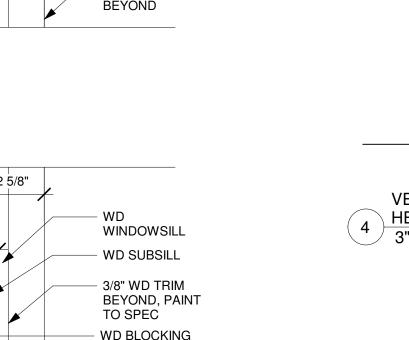

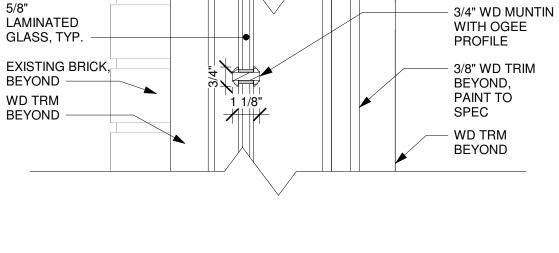

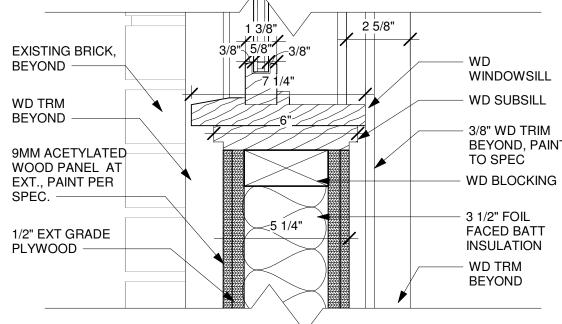

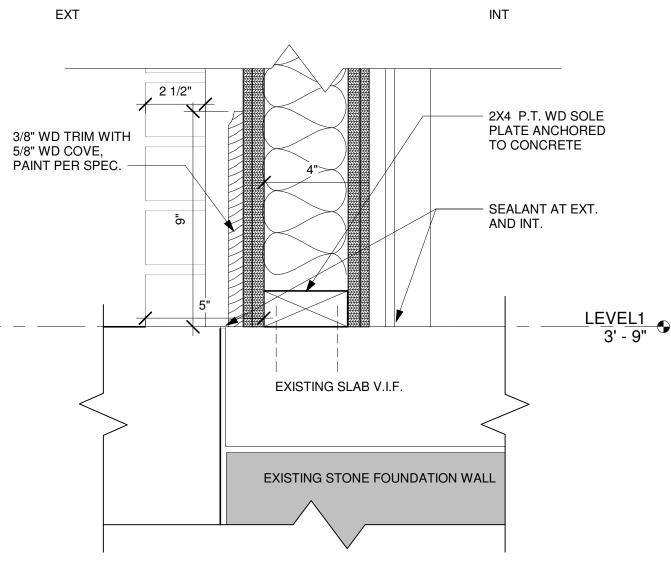

### VERTICAL SECTION AT SIDELITE

5 SECTION AT THRESHOLD DETAIL 3" = 1'-0"



EXISTING GWB FINISH FACE; PATCH AND PATCH AS REQ'D

WD BLOCKING AND RADIUSED INNER FRAME FOR ARC; FASTEN INTO BRICK

- I" WD TRIM; PAINT TO MATCH SPEC WINDOW FRAME (RADIUSED)

INT

- 3 1/4" WD SASH WITH 5/8" INSULATED GLASS

– I" WD TRIM; PAINT TO MATCH SPEC

- NEW 1 3/4" X 5 1/2" LVL - 2X6 BLOCKING

<u>TOP OF LINTEL</u> 11' - 9"

WOOD DOOR FRAME WEATHER STRIPPING

PER HDWR SPEC DOOR

> - DOOR PROVIDE WEATHER

STRIPPING PER SPEC

WOOD JAMB STOP

1" WOOD DOOR FRAME

INT

PROVIDE NEW METAL THRESHOLD SET IN MASTIC PER SPEC FINISH FLOOR

LEVEL1 3' - 9"

THESE DOCUMENTS, SUBMITTED FOR THE SPECIFIC PROJECT NAMELY RENOVATE EXTERIOR FACADE & PERIMETER HEATING SYSTEM AT ALLEN HALL, STATE UNIVERSITY COLLEGE AT BROCKPORT, BROCKPORT, NEW YORK ARE AN INSTRUMENT OF SERVICE AND ARE NOT TO BE ALTERED, COPIED, OR USED FOR ANY OTHER PROJECT WITHOUT THE EXPRESSED WRITTEN PERMISSION OF FLYNN BATTAGLIA ARCHITECTS, PC. IT IS A VIOLATION OF THE LAW FOR ANY PERSON, UNLESS UNDER THE DIRECTION OF A LICENSED ARCHITECT OR ENGINEER, TO ALTER ANY ITEMS IN THESE DOCUMENTS IN ANY WAY. IF ANY ITEM IS ALTERED, THE ALTERING ARCHITECT/ENGINEER SHALL AFFIX HIS/HER SEAL ALONG WITH THE NOTATION "ALTERED BY" FOLLOWED BY HIS/HER SIGNATURE AND THE DATE OF SUCH ALTERATION, AND A SPECIFIC DESCRIPTION OF THE ALTERATION. COPYRIGHT 2017 FLYNN BATTAGLIA ARCHITECTS, PC, ALL RIGHTS RESERVED.

DATE 09/1/2023

R FLYNN|BATTAGLIA

THE REGISTERED PROFESSIONAL CERTIFIES THAT THIS PROJECT HAS BEEN DESIGNED BY ME, OR UNDER MY SUPERVISION, IN ACCORDANCE WITH: THE BUILDING CODE OF NEW YORK STATE AND THE ENERGY CONSERVATION CODE OF NEW YORK STATE AND APPLICABLE FEDERAL LAWS AND REGULATIONS AND TO THE BEST OF MY KNOWLEDGE AND BELIEF, THESE CONSTRUCTION DOCUMENTS ARE IN CONFORMANCE THEREWITH.

617 Main Street, Suite 401

Buffalo, New York 14203

Telephone (716) 854-2424

TOWN OF ELLICOTTVILLE


Ellicottville Town Hall

I West Washington St, Ellicottville, NY 14731

CONTRACT DOCUMENTS NOTES & REVISIONS: Revision Schedule Description Revision Number Date DRAWING ISSUED: January 25, 2024 Project Number: Scale: 3" = 1'-0" 00410 Drawn By: Checked By: ADF MM Drawing Title ENTRANCE AND DOOR DETAILS

Drawing Number

A1-02

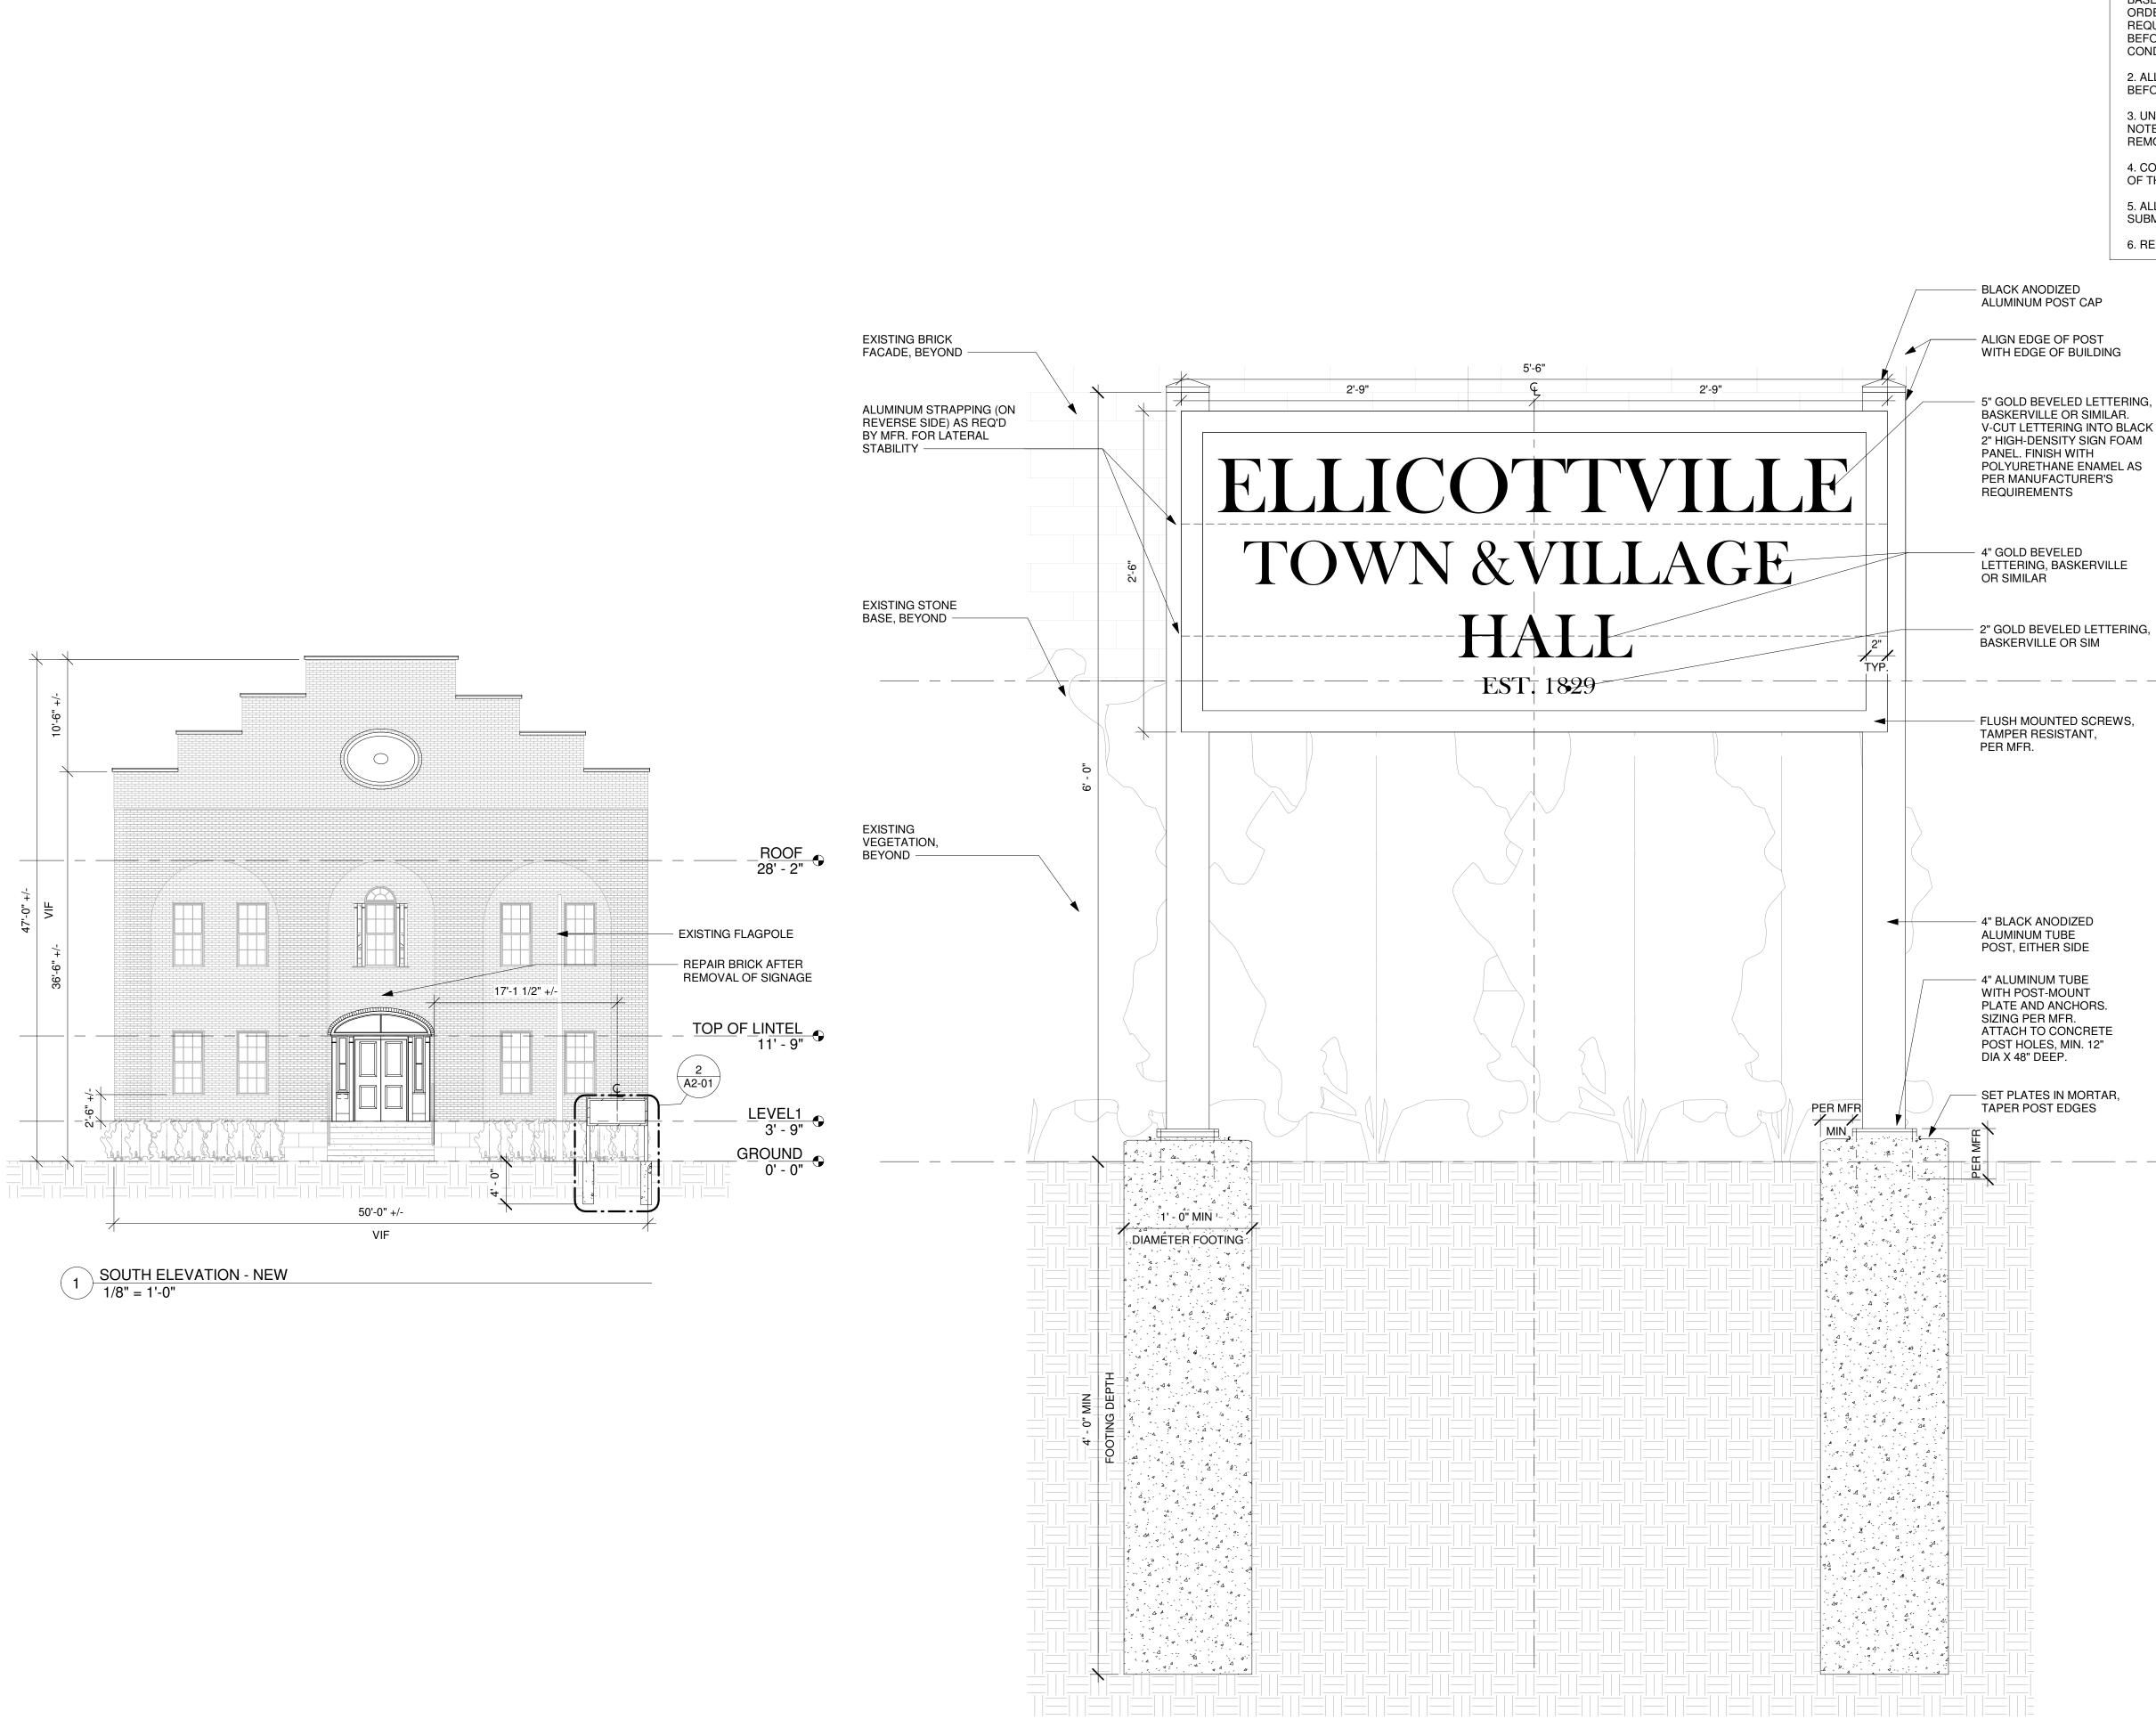

2 SIGNAGE - PROPOSED 1 1/2" = 1'-0"

### **GENERAL NOTES**

1. QUANTITIES AND DIMENSIONS SHOWN ON THIS DRAWING ARE BASED ON FIELD OBSERVATION AND ARE INTENDED TO SERVE AS ORDER OF MAGNITUDE INDICATIONS OF WORK. ACTUAL REQUIREMENTS MAY VARY. VERIFY ALL DIMENSIONS IN FIELD BEFORE PROCEEDING WITH WORK. NOTIFY ARCHITECT IF EXISTING CONDITIONS OCCUR DIFFERENTLY THAN DOCUMENTED.

2. ALL DIMENSIONS ARE +/- AND ARE TO BE VERIFIED IN FIELD BEFORE PROCEEDING WITH WORK.

3. UNLESS OTHERWISE NOTED, ALL REMOVALS IDENTIFIED IN THESE NOTES BECOME PROPERTY OF THE CONTRACTOR MAKING THE REMOVAL.

4. COORDINATE ALL WORK INDICATED ON THIS DRAWING WITH THAT OF THE OTHER TRADES.

5. ALL FINISH COLORS TO BE SELECTED BY ARCHITECT FROM SUBMITTALS BY CONTRACTOR FOR SPECIFIED PRODUCTS. 6. RESTORE SITE TO ORIGINAL CONDITIONS AS FOUND.

GENERAL NOTE: ALL FINISH COLORS TO BE SELECTED AND VERIFIED BY ARCHITECT.

LEVEL1 3' - 9"

<u>GROUND</u> 0' - 0"

THESE DOCUMENTS, SUBMITTED FOR THE SPECIFIC PROJECT NAMELY RENOVATE EXTERIOR FACADE & PERIMETER HEATING SYSTEM AT ALLEN HALL, STATE UNIVERSITY COLLEGE AT BROCKPORT, BROCKPORT, NEW YORK ARE AN INSTRUMENT OF SERVICE AND ARE NOT TO BE ALTERED, COPIED, OR USED FOR ANY OTHER PROJECT WITHOUT THE EXPRESSED WRITTEN PERMISSION OF FLYNN BATTAGLIA ARCHITECTS, PC. IT IS A VIOLATION OF THE LAW FOR ANY PERSON, UNLESS UNDER THE DIRECTION OF A LICENSED ARCHITECT OR ENGINEER, TO ALTER ANY ITEMS IN THESE DOCUMENTS IN ANY WAY. IF ANY ITEM IS ALTERED, THE ALTERING ARCHITECT/ENGINEER SHALL AFFIX HIS/HER SEAL ALONG WITH THE NOTATION "ALTERED BY" FOLLOWED BY HIS/HER SIGNATURE AND THE DATE OF SUCH ALTERATION, AND A SPECIFIC DESCRIPTION OF THE ALTERATION. COPYRIGHT 2017 FLYNN BATTAGLIA ARCHITECTS, PC, ALL RIGHTS RESERVED. THE REGISTERED PROFESSIONAL CERTIFIES THAT THIS PROJECT HAS BEEN DESIGNED BY ME, OR UNDER MY SUPERVISION, IN ACCORDANCE WITH: THE BUILDING CODE OF NEW YORK STATE AND THE ENERGY CONSERVATION CODE OF NEW YORK STATE AND APPLICABLE FEDERAL LAWS AND REGULATIONS AND TO THE BEST OF MY KNOWLEDGE AND BELIEF, THESE CONSTRUCTION DOCUMENTS ARE DATE 09/1/2023 IN CONFORMANCE THEREWITH. R FLYNNBATTAGLIA 617 Main Street, Suite 401 Buffalo, New York 14203 Telephone (716) 854-2424 TOWN OF ELLICOTTVILLE

Ellicottville Town Hall

I West Washington St, Ellicottville, NY 14731

NOTES & REV	/ISIONS:	
	Revisi	on Schedule
Revision Number	Date	Description
	0	
DRAWING IS	SUED:	January 25, 20
Project Numb	er:	Scale:
00410		As indicated
Drawn By:		Checked By:
ADF		MM
Drawing Title SOUTH   DETAIL	ELEVA	TION AND SIGNA

### Short Environmental Assessment Form Part 1 - Project Information

#### Instructions for Completing

**Part 1 – Project Information. The applicant or project sponsor is responsible for the completion of Part 1.** Responses become part of the application for approval or funding, are subject to public review, and may be subject to further verification. Complete Part 1 based on information currently available. If additional research or investigation would be needed to fully respond to any item, please answer as thoroughly as possible based on current information.


Complete all items in Part 1. You may also provide any additional information which you believe will be needed by or useful to the lead agency; attach additional pages as necessary to supplement any item.

Part 1 – Project and Sponsor Information		
Name of Action or Project: Town Hall Front Door Replacement		
Project Location (describe, and attach a location map): 1 W Washington Street, Tax Parcel ID 55.035-3-50		
Brief Description of Proposed Action: Replace existing front door and remove existing wall sign		
Name of Applicant or Sponsor:	Telephone: (716) 699-210	00
Town of Ellicottville	E-Mail: N/A	
Address: 1 W Washington Street		
City/PO: PO Box 600	State: New York	Zip Code: 14731
<ol> <li>Does the proposed action only involve the legislative adoption of a plan, loca administrative rule, or regulation?</li> <li>If Yes, attach a narrative description of the intent of the proposed action and the e may be affected in the municipality and proceed to Part 2. If no, continue to ques</li> <li>Does the proposed action require a permit, approval or funding from any other</li> </ol>	nvironmental resources th tion 2. er government Agency?	
If Yes, list agency(s) name and permit or approval: Village of Ellicottville - Architectura Review and Building Permit	Design Review, Historic Dis	trict
<ul> <li>a. Total acreage of the site of the proposed action?</li> <li>b. Total acreage to be physically disturbed?</li> <li>c. Total acreage (project site and any contiguous properties) owned or controlled by the applicant or project sponsor?</li> </ul>	0.42 acres 0.00 acres 0.42 acres	Λ.
<ul> <li>4. Check all land uses that occur on, are adjoining or near the proposed action:</li> <li>5.  Urban Rural (non-agriculture) Industrial  Commercia</li> <li>Forest Agriculture Aquatic Other(Spece</li> <li>Parkland</li> </ul>	· ·	rban)

5. Is the proposed action,	NO	YES	N/A
a. A permitted use under the zoning regulations?			
b. Consistent with the adopted comprehensive plan?			
6. Is the proposed action consistent with the predominant character of the existing built or natural landscape?	,	NO	YES
7. Is the site of the proposed action located in, or does it adjoin, a state listed Critical Environmental Area?		NO	YES
If Yes, identify:			
		NO	YES
8. a. Will the proposed action result in a substantial increase in traffic above present levels?			
b. Are public transportation services available at or near the site of the proposed action?			
c. Are any pedestrian accommodations or bicycle routes available on or near the site of the proposed action?			
9. Does the proposed action meet or exceed the state energy code requirements?		NO	YES
If the proposed action will exceed requirements, describe design features and technologies:			
	<u> </u>		
10. Will the proposed action connect to an existing public/private water supply?		NO	YES
If No, describe method for providing potable water:			
11. Will the proposed action connect to existing wastewater utilities?		NO	YES
If No, describe method for providing wastewater treatment:			
	-2		
12. a. Does the project site contain, or is it substantially contiguous to, a building, archaeological site, or distri-	et	NO	YES
which is listed on the National or State Register of Historic Places, or that has been determined by the Commissioner of the NYS Office of Parks, Recreation and Historic Preservation to be eligible for listing on the	2		
State Register of Historic Places?			
Town Hall/Old Cattaraugus County Court House (USN 00947.000001)	8		
b. Is the project site, or any portion of it, located in or adjacent to an area designated as sensitive for archaeological sites on the NY State Historic Preservation Office (SHPO) archaeological site inventory?			
13. a. Does any portion of the site of the proposed action, or lands adjoining the proposed action, contain wetlands or other waterbodies regulated by a federal, state or local agency?		NO	YES
b. Would the proposed action physically alter, or encroach into, any existing wetland or waterbody?			
If Yes, identify the wetland or waterbody and extent of alterations in square feet or acres:			
			19-18

14. Identify the typical habitat types that occur on, or are likely to be found on the project site. Check all that apply:		
Shoreline Forest Agricultural/grasslands Early mid-successional		
□Wetland 🖌 Urban □ Suburban		
15. Does the site of the proposed action contain any species of animal, or associated habitats, listed by the State or	NO	YES
Federal government as threatened or endangered?		
16. Is the project site located in the 100-year flood plan?	NO	YES
17. Will the proposed action create storm water discharge, either from point or non-point sources? If Yes,	NO	YES
a. Will storm water discharges flow to adjacent properties?		
b. Will storm water discharges be directed to established conveyance systems (runoff and storm drains)? If Yes, briefly describe:		
		成しる
18. Does the proposed action include construction or other activities that would result in the impoundment of water or other liquids (e.g., retention pond, waste lagoon, dam)?	NO	YES
If Yes, explain the purpose and size of the impoundment:		
19. Has the site of the proposed action or an adjoining property been the location of an active or closed solid waste management facility?	NO	YES
If Yes, describe:		
20.Has the site of the proposed action or an adjoining property been the subject of remediation (ongoing or completed) for hazardous waste?	NO	YES
If Yes, describe:		
Former Signore Site (C905034 and 905023)		
I CERTIFY THAT THE INFORMATION PROVIDED ABOVE IS TRUE AND ACCURATE TO THE BI MY KNOWLEDGE	EST OF	<u> </u>
Applicant/sponsor/name: Gregory D. Keyser Date: 1/29/2024		
Signature: Duppy D. They Title: For PANNE	R	

### EAF Mapper Summary Report

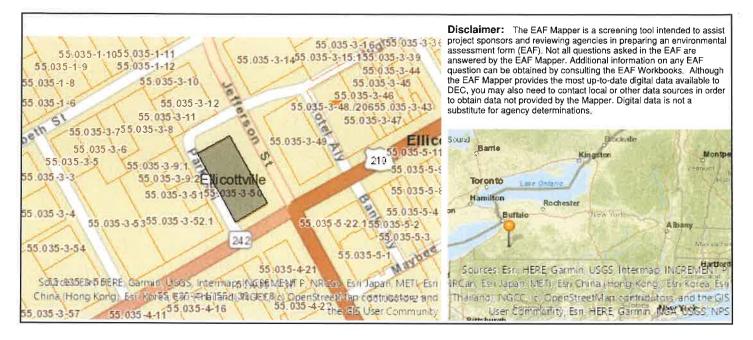

Part 1 / Question 7 [Critical Environmental Area]	No
Part 1 / Question 12a [National or State Register of Historic Places or State Eligible Sites]	Yes
Part 1 / Question 12b [Archeological Sites]	No
Part 1 / Question 13a [Wetlands or Other Regulated Waterbodies]	No
Part 1 / Question 15 [Threatened or Endangered Animal]	No
Part 1 / Question 16 [100 Year Flood Plain]	Digital mapping data are not available or are incomplete. Refer to EAF Workbook.
Part 1 / Question 20 [Remediation Site]	Yes



KATHY HOCHUL Governor ERIK KULLESEID Commissioner

November 28, 2023

Aubrey Fan Flynn Battaglia Architects 617 Main Street Suite S-401 Buffalo, NY 14203

Re: DASNY Ellicottville Town Hall Entance 1 Washington St, Ellicottville, NY 14731 23PR09748

Dear Aubrey Fan:

Thank you for requesting the comments of the Division for Historic Preservation of the Office of Parks, Recreation and Historic Preservation (OPRHP). We have reviewed the submitted materials in accordance with the New York State Historic Preservation Act of 1980 (Section 14.09 of the New York State Parks, Recreation and Historic Preservation Law). These comments are those of the Division for Historic Preservation and relate only to Historic/Cultural resources. They do not include potential environmental impacts to New York State Parkland that may be involved in or near your project. Such impacts must be considered as part of the environmental review of the project pursuant to the State Environmental Quality Review Act (New York Environmental Conservation Law Article 8) and its implementing regulations (6 NYCRR § 617).

The Ellicottville Town and Village Hall contributes to the Ellicottville Historic District, which is listed in the State and National Registers of Historic Places. Our office has reviewed the November 14, 2023 work scope, which proposed replacement of the deteriorated, non-historic entry, as well as new signage. Based upon our review, it is the OPRHP's opinion that this project will have No Adverse Impact on historic resources.

If you have any questions, I am best reached by email.

Sincerely,

Derek Rohde Historic Site Restoration Coordinator 518-275-5745 | <u>Derek.Rohde@parks.ny.gov</u>